



**BUILDING CODE COMPLIANCE OFFICE (BCCO)
PRODUCT CONTROL DIVISION**

**MIAMI-DADE COUNTY, FLORIDA
METRO-DADE FLAGLER BUILDING**

**140 WEST FLAGLER STREET, SUITE 1603
MIAMI, FLORIDA 33130-1563
(305) 375-2901 FAX (305) 375-2908**

www.buildingcodeonline.com

NOTICE OF ACCEPTANCE (NOA)

**Fort Hurricane Products, Inc.
1100 25TH Street (Unit 7 A)
West Palm Beach, Florida 33407**

SCOPE:

This NOA is being issued under the applicable rules and regulations governing the use of construction materials. The documentation submitted has been reviewed by Miami-Dade County Product Control Division and accepted by the Board of Rules and Appeals (BORA) to be used in Miami Dade County and other areas where allowed by the Authority Having Jurisdiction (AHJ).

This NOA shall not be valid after the expiration date stated below. The Miami-Dade County Product Control Division (In Miami Dade County) and/or the AHJ (in areas other than Miami Dade County) reserve the right to have this product or material tested for quality assurance purposes. If this product or material fails to perform in the accepted manner, the manufacturer will incur the expense of such testing and the AHJ may immediately revoke, modify, or suspend the use of such product or material within their jurisdiction. BORA reserves the right to revoke this acceptance, if it is determined by Miami-Dade County Product Control Division that this product or material fails to meet the requirements of the applicable building code.

This product is approved as described herein, and has been designed to comply with the High Velocity Hurricane Zone of the Florida Building Code.

DESCRIPTION: 280P / Operable Impact Resistant Window Screen

APPROVAL DOCUMENT: Drawing No. HSS0001, titled "280P / Egress Operable Impact Resistant Window Screen", sheets 1 through 5 of 5, prepared by PTC Engineering, Inc., dated April 19, 2005, last revision #A dated July 06, 2005, signed and sealed by L. Roberto Lomas, P.E., bearing the Miami-Dade County Product Control Approval stamp with the Notice of Acceptance number and approval date by the Miami-Dade County Product Control Division.

MISSILE IMPACT RATING: Large and Small Missile Impact

LABELING: Each unit shall bear a permanent label with the manufacturer's name or logo, city, state and the following statement: "Miami-Dade County Product Control Approved", unless otherwise noted herein.

RENEWAL of this NOA shall be considered after a renewal application has been filed and there has been no change in the applicable building code negatively affecting the performance of this product.

TERMINATION of this NOA will occur after the expiration date or if there has been a revision or change in the materials, use, and/or manufacture of the product or process. Misuse of this NOA as an endorsement of any product, for sales, advertising or any other purposes shall automatically terminate this NOA. Failure to comply with any section of this NOA shall be cause for termination and removal of NOA.

ADVERTISEMENT: The NOA number preceded by the words Miami-Dade County, Florida, and followed by the expiration date may be displayed in advertising literature. If any portion of the NOA is displayed, then it shall be done in its entirety.

INSPECTION: A copy of this entire NOA shall be provided to the user by the manufacturer or its distributors and shall be available for inspection at the job site at the request of the Building Official.

This NOA consists of this page 1, evidence submitted page (s) as well as approval document mentioned above. The submitted documentation was reviewed by **Helmy A. Makar, P.E.**



Helmy A. Makar
08/11/2005

**NOA No 05-0520.02
Expiration Date: 08/11/2010
Approval Date: 08/11/2005
Page 1**

Fort Hurricane Products, Inc.

NOTICE OF ACCEPTANCE: EVIDENCE SUBMITTED

A. DRAWINGS

1. *Drawing No. HSS0001, titled " 280P / Egress Operable Impact Resistant Window Screen", sheets 1 through 5 of 5, prepared by PTC Engineering, Inc., dated April 19, 2005, last revision #A dated July 06, 2005, signed and sealed by L. Roberto Lomas, P.E.*

B. TESTS

1. *Test report on Large Missile Impact Test, Cyclic Wind Pressure Test and Uniform Static Air Pressure Test on " Impact Screen Window", prepared by Certified Testing Laboratories, Report No. CTLA 1366W, dated April 5, 2005, signed and sealed by Ramesh Patel, P.E.*
2. *Revised and marked up drawings from test lab (Certified Testing Laboratories).*

C. CALCULATIONS

1. *Anchor calculations prepared by PTC Engineering, Inc., dated May 13, 2005, sheets 1 through 7 of 7, signed and sealed by L. Roberto Lomas, P.E.*
2. *Revised Anchor calculation prepared by PTC Engineering, Inc., dated July 7, 2005, sheets 1 through 7 of 7, signed and sealed by L. Roberto Lomas, P.E.*

D. QUALITY ASSURANCE


1. *By Miami-Dade County Building Code Compliance Office.*

E. MATERIAL CERTIFICATIONS

1. *Die drawings.*



Helmy A. Makar, P. E.
Product Control Examiner
NOA No 05-0520.02
Expiration Date: 08/11/2010
Approval Date: 08/11/2005

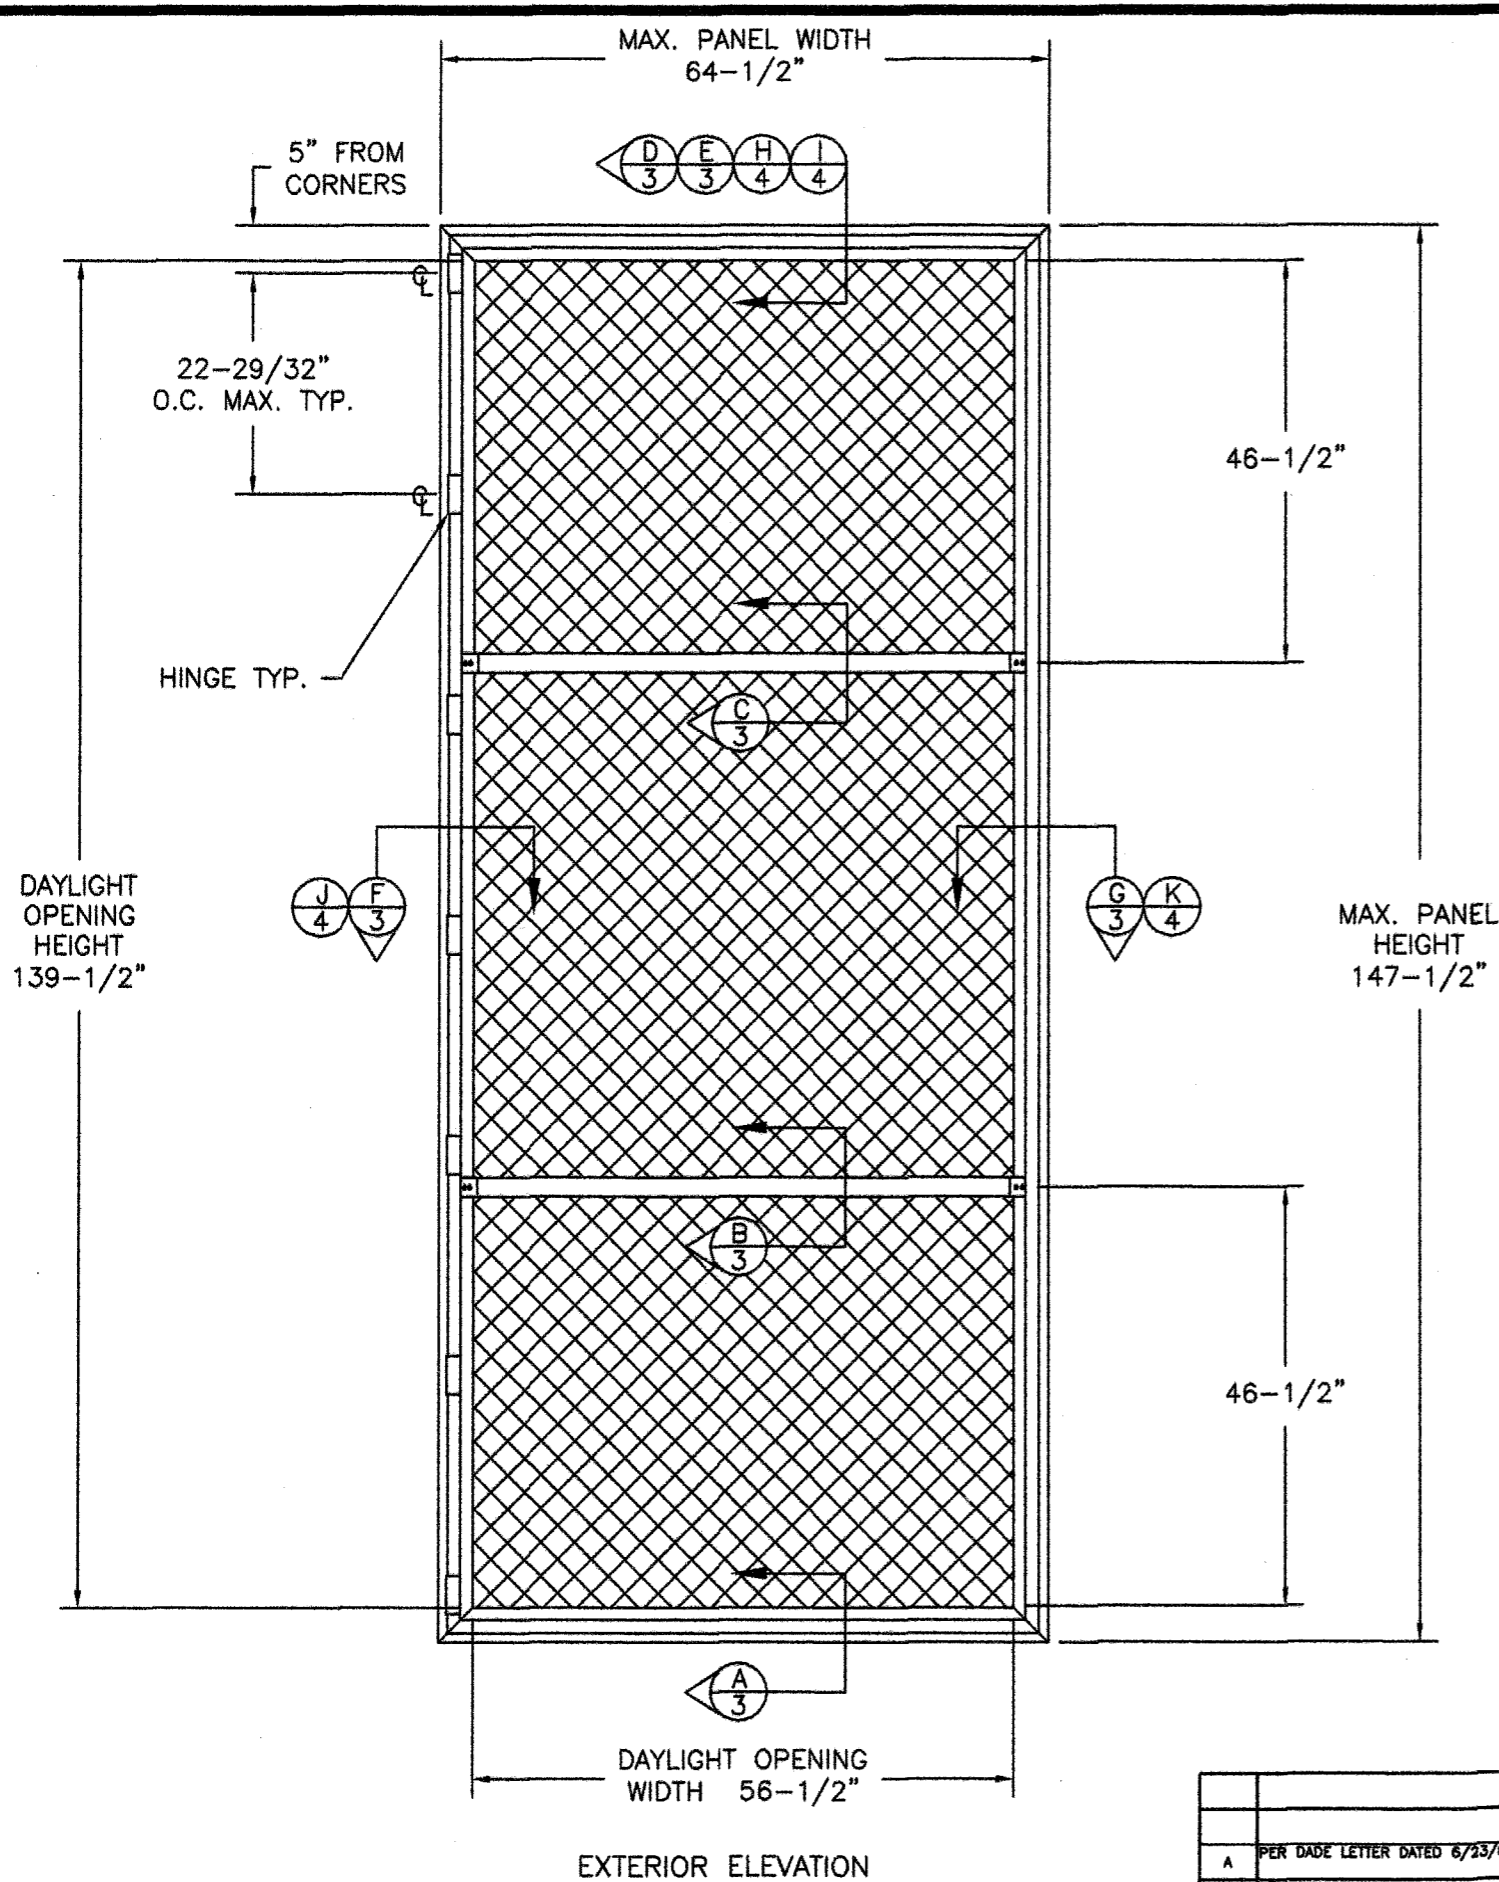

GENERAL NOTES:

1. THE PRODUCT SHOWN HEREIN IS DESIGNED AND MANUFACTURED TO COMPLY WITH THE 2001 AND 2004 "HVHZ" FLORIDA BUILDING CODE.
2. CONCRETE, MASONRY AND WOOD FRAMING TO BE DESIGNED AND ANCHORED TO PROPERLY TRANSFER ALL LOADS TO STRUCTURE. FRAMING IS THE RESPONSIBILITY OF THE ARCHITECT OR ENGINEER OF RECORD.
3. PANEL FRAME MATERIAL: ALUMINUM ALLOY 6005-T6.
4. A MINIMUM GLASS SEPARATION DISTANCE OF 4" SHALL BE PROVIDED FOR ALL INSTALLATIONS.

TABLE OF CONTENT	
SHEET	DESCRIPTION
1	ELEVATION NOTES
2	ANCHORING & NOTES
3	INSTALLATION DETAILS IN CONCRETE & WOOD FRAME
4	INSTALLATION DETAILS IN CONCRETE & WOOD FRAME
5	COMPONENTS & B.O.M.

MAXIMUM ALLOWABLE DESIGN PRESSURES	
W/2-1/2" MIN. EDGE DISTANCE	
+67.0 PSF	
-76.0 PSF	

Approved as complying with the Florida Building Code
 Date 08/11/2005
 NOA# 05-0570-02
 Miami Dade Product Control
 Division
 By Hedwig A. Meder


L. Roberto Lomas
 7/08/05
 L. Roberto Lomas, P.E.
 Florida P. E. No. 62514
 PTC Engineering, Inc.
 2361 S.E. Seafury Lane
 Port St. Lucie, Florida 34952
 FBPE Certificate of Authorization NO. 25935

FORT HURRICANE PRODUCTS, INC.
 1100 25TH ST. UNIT 7A WEST PALM BEACH, FL. 33407
 TITLE: 280P/ EGRESS OPERABLE IMPACT RESISTANT WINDOW SCREEN
 ELEVATION & NOTES

PREPARED BY: PTC PTC ENGINEERING, INC.	DRN: BB	DATE: 4/19/05
SCALE: N.T.S.	DWG. NO: HSS0001	
REV: A	SHEET: 1 OF 5	

Phone 772.398.4639 Fax 772.398.4654

SYM	REVISION	DATE	BY
A	PER DADE LETTER DATED 6/23/05	07/08/05	BB

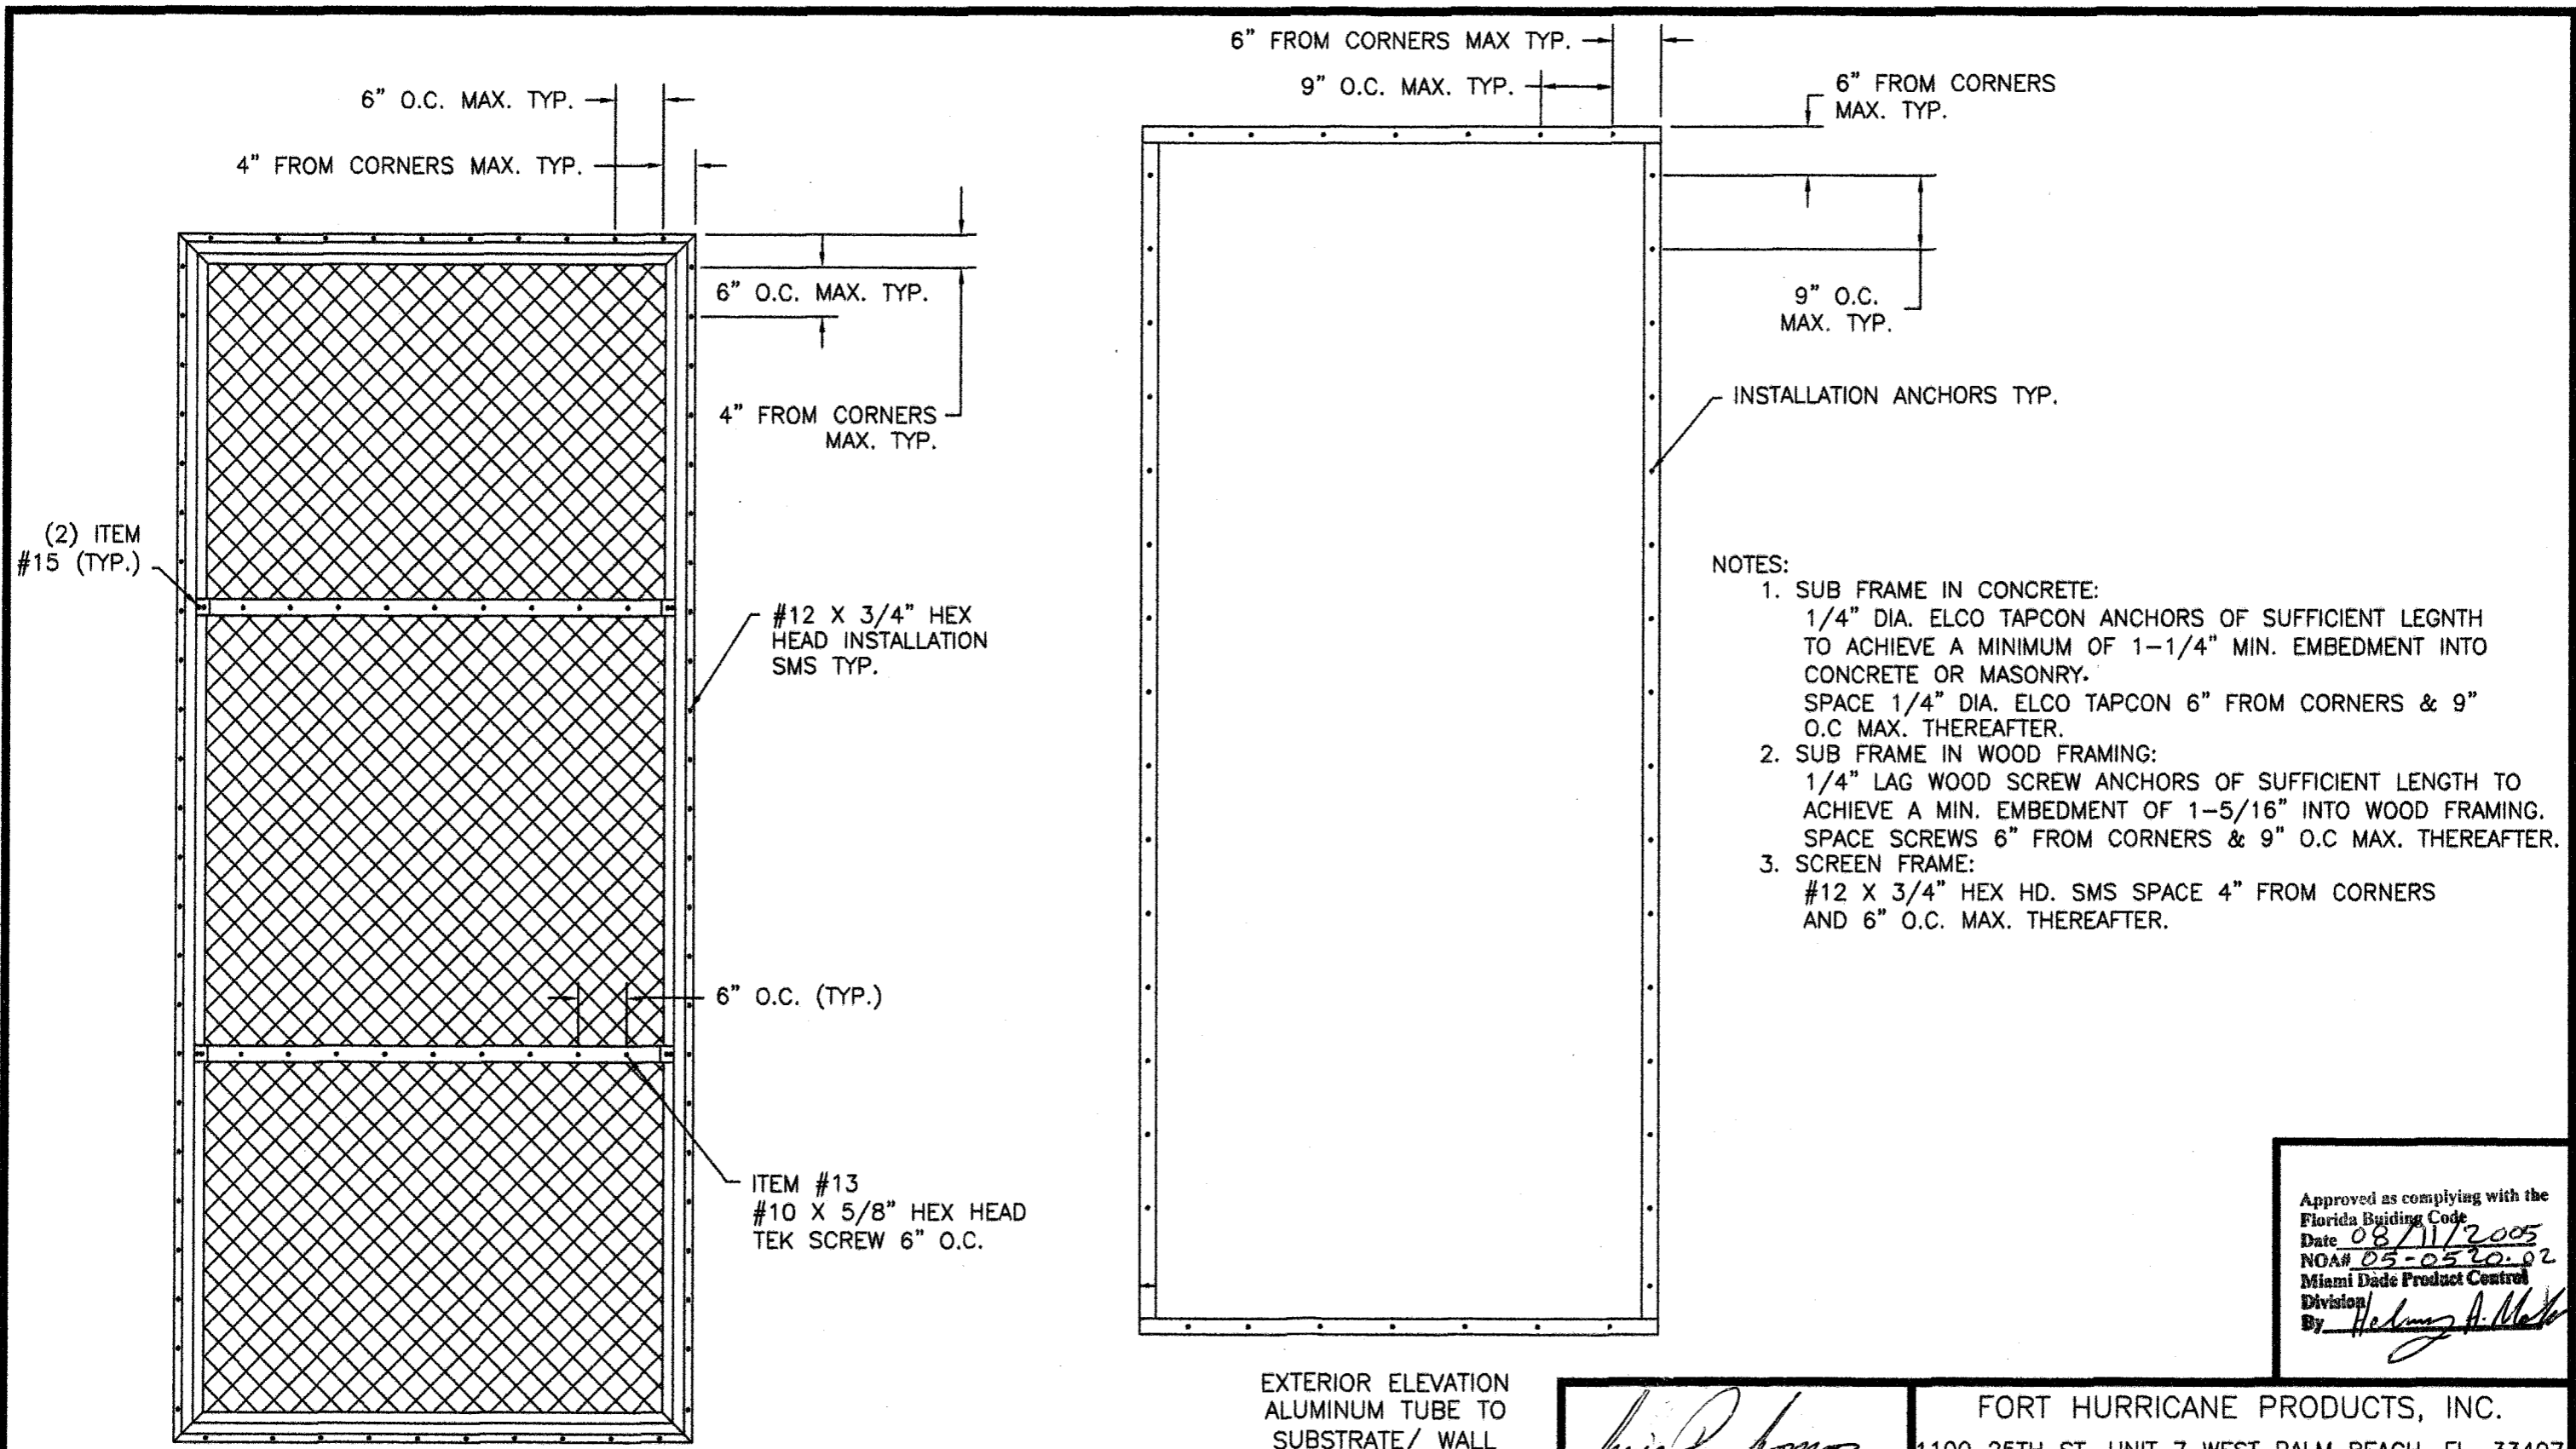

- NOTES:
- SUB FRAME IN CONCRETE:
1/4" DIA. ELCO TAPCON ANCHORS OF SUFFICIENT LENGTH TO ACHIEVE A MINIMUM OF 1-1/4" MIN. EMBEDMENT INTO CONCRETE OR MASONRY.
SPACE 1/4" DIA. ELCO TAPCON 6" FROM CORNERS & 9" O.C. MAX. THEREAFTER.
 - SUB FRAME IN WOOD FRAMING:
1/4" LAG WOOD SCREW ANCHORS OF SUFFICIENT LENGTH TO ACHIEVE A MIN. EMBEDMENT OF 1-5/16" INTO WOOD FRAMING.
SPACE SCREWS 6" FROM CORNERS & 9" O.C. MAX. THEREAFTER.
 - SCREEN FRAME:
#12 X 3/4" HEX HD. SMS SPACE 4" FROM CORNERS AND 6" O.C. MAX. THEREAFTER.

Approved as complying with the Florida Building Code
 Date 08/11/2005
 NOA# 05-0520-02
 Miami Dade Product Control Division
 By *Helmut A. Mehl*

EXTERIOR ELEVATION PANEL TO ALUMINUM TUBE ANCHORING

EXTERIOR ELEVATION ALUMINUM TUBE TO SUBSTRATE/ WALL ANCHORING

SYM	REVISION	DATE	BY
A	PER DADE LETTER DATED 06/??/05	07/06/05	BB


Luis R. Lomas
 7/08/05
 L. Roberto Lomas, P.E.
 Florida P. E. No. 62514
 PTC Engineering, Inc.
 2361 S.E. Seafury Lane
 Port St. Lucie, Florida 34952
 FBPE Certificate of Authorization NO. 25935

FORT HURRICANE PRODUCTS, INC.
 1100 25TH ST. UNIT 7 WEST PALM BEACH, FL. 33407
 TITLE: 280P/ EGRESS OPERABLE IMPACT RESISTANT WINDOW SCREEN

ANCHORING & NOTES

PREPARED BY: **PTC** PTC ENGINEERING, INC.
 Phone 772.398.4639 Fax 772.398.4654

DRN:	BB	DATE:	4/19/05
SCALE:	N.T.S.	DWG. NO.:	HSS0001
REV:	A	SHEET:	2 OF 5

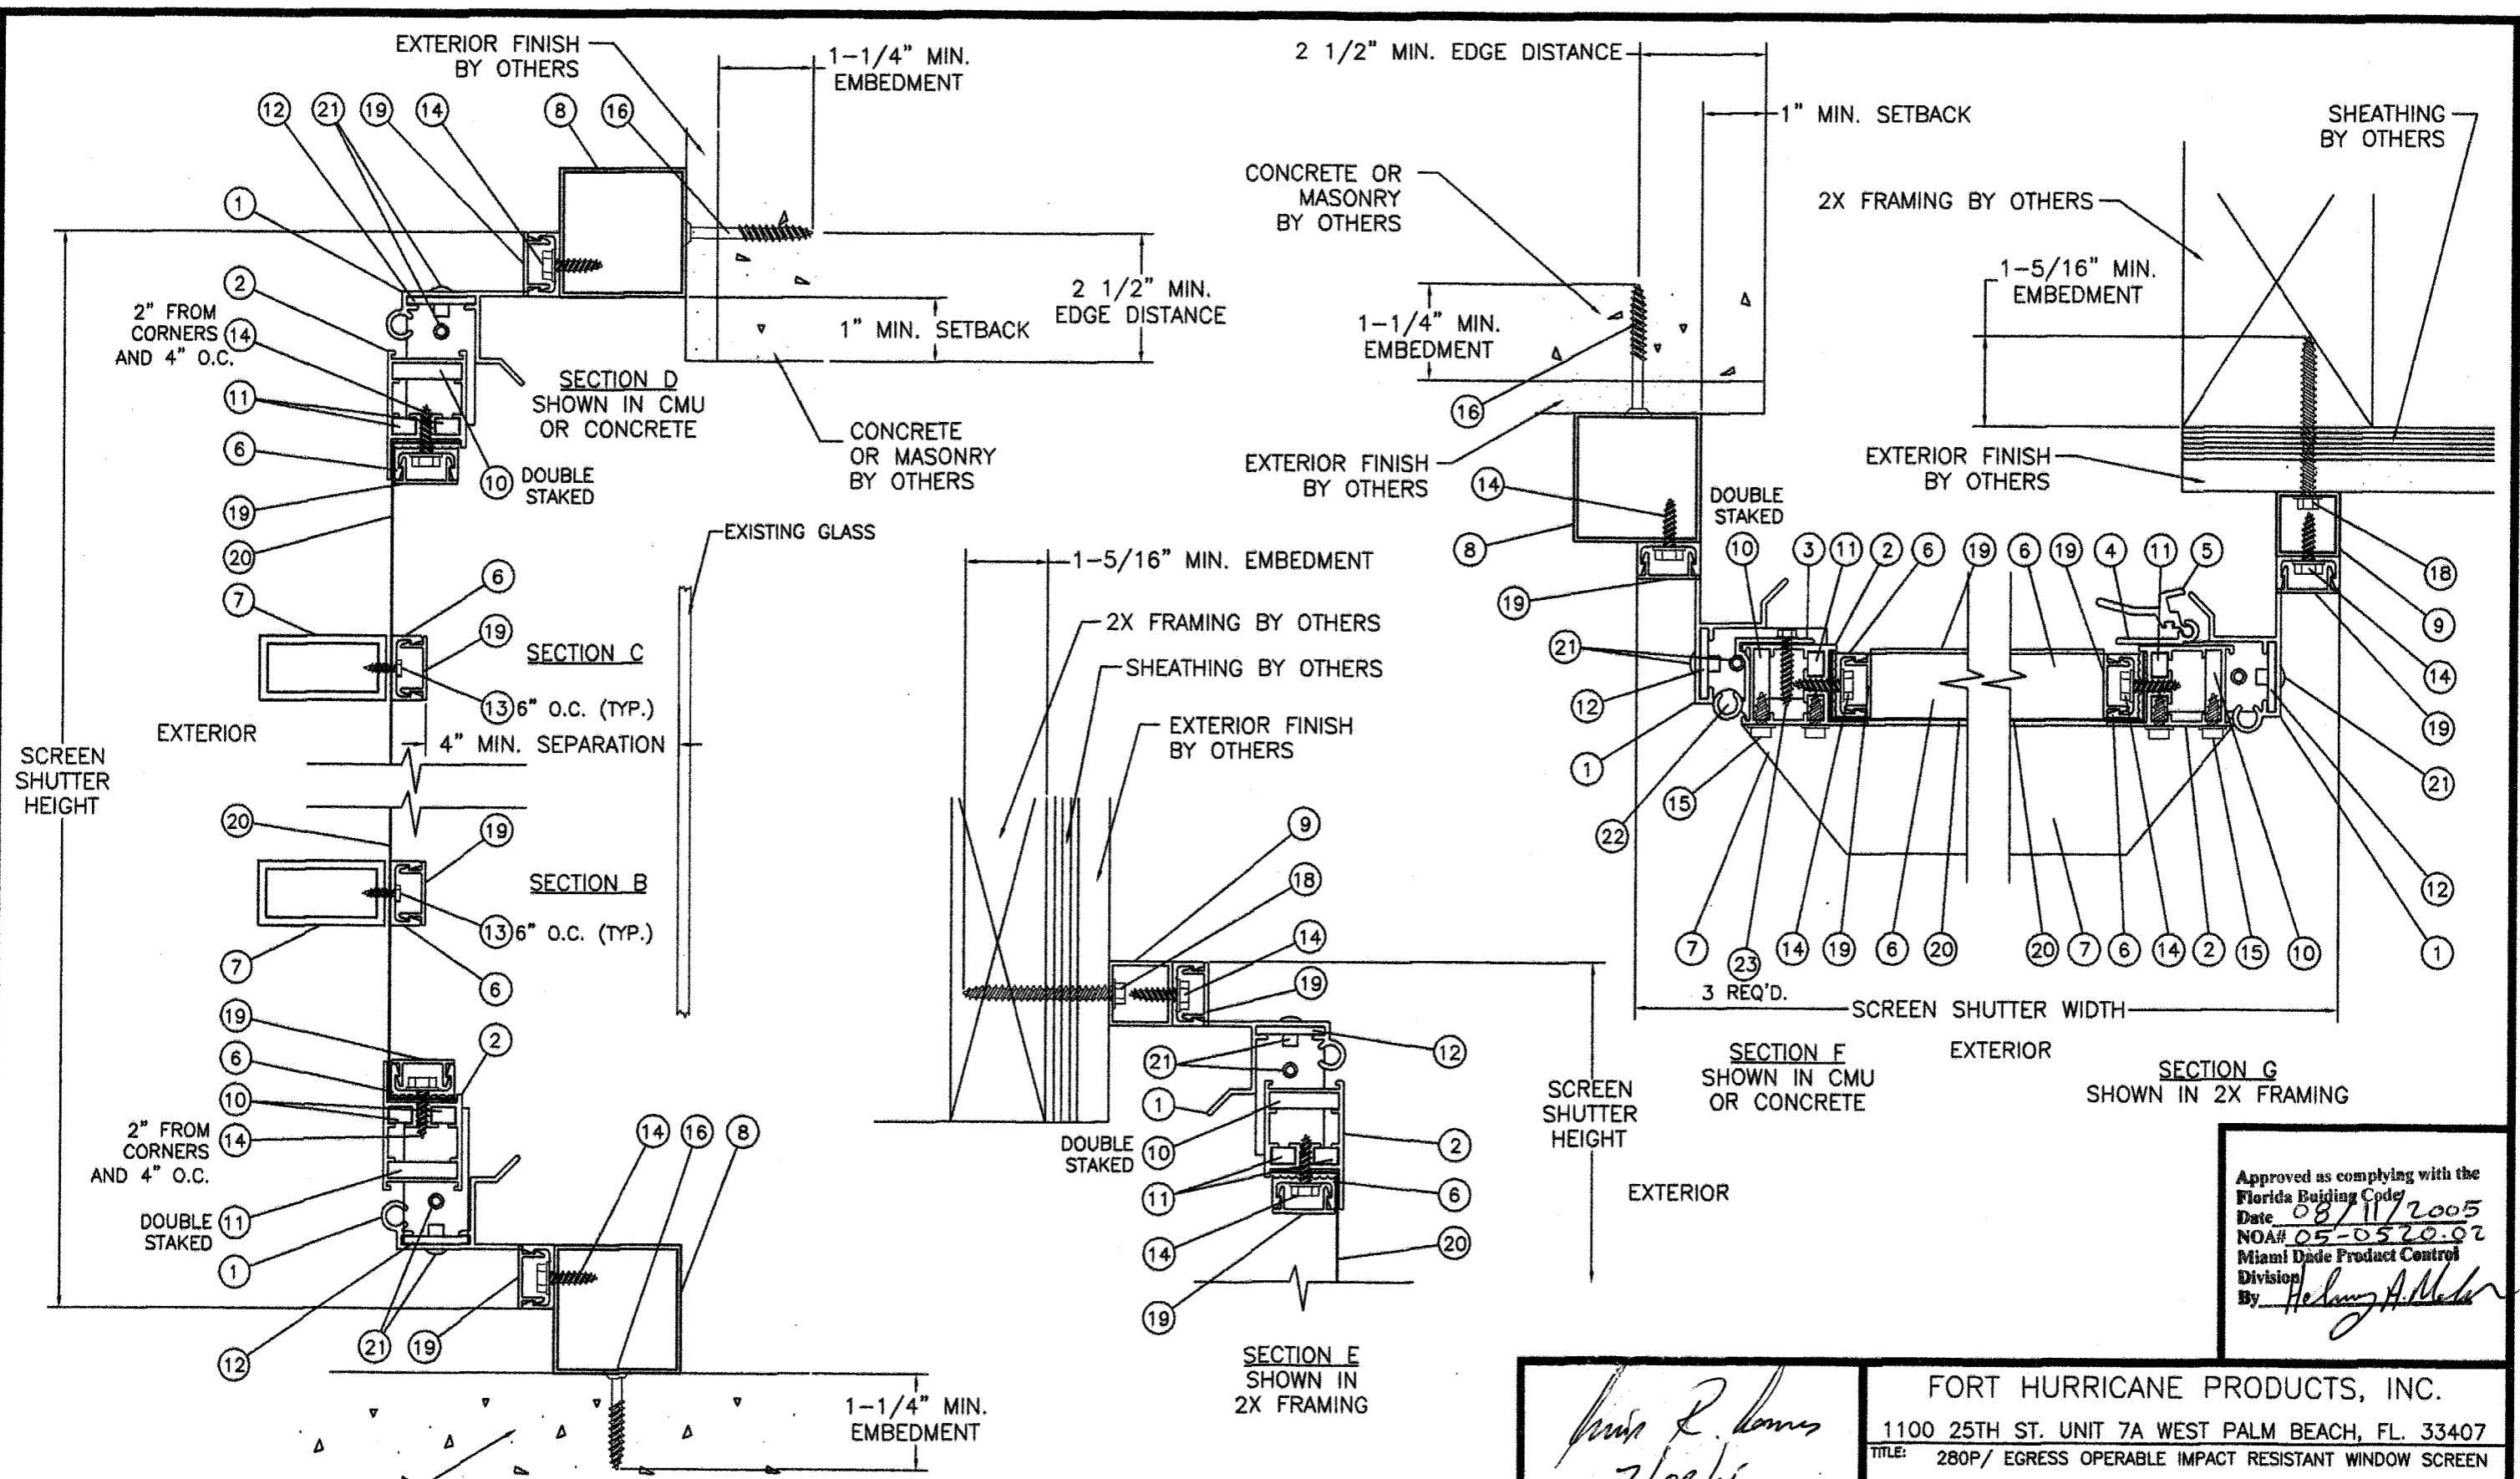


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 Date 08/11/2005
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 Miami Dade Product Control Division
 By Heung A. Meder

L. Roberto Lomas
 7/08/05
 L. Roberto Lomas, P.E.
 Florida P. E. No. 62514
 PTC Engineering, Inc.
 2361 S.E. Seafury Lane
 Port St. Lucie, Florida 34952
 FBPE Certificate of Authorization NO. 25935

FORT HURRICANE PRODUCTS, INC.
 1100 25TH ST. UNIT 7A WEST PALM BEACH, FL. 33407
 TITLE: 280P/ EGRESS OPERABLE IMPACT RESISTANT WINDOW SCREEN
 INSTALLATION DETAILS IN CONCRETE & WOOD FRAME
 PREPARED BY: **PTC** PTC ENGINEERING, INC.
 DRN: BB DATE: 4/19/05
 SCALE: N.T.S. DWG. NO: HSS0001
 REV: A SHEET: 3 OF 5

SYM	REVISION	DATE	BY
A	PER DADE LETTER DATED 08/23/05	08/23/05	BB

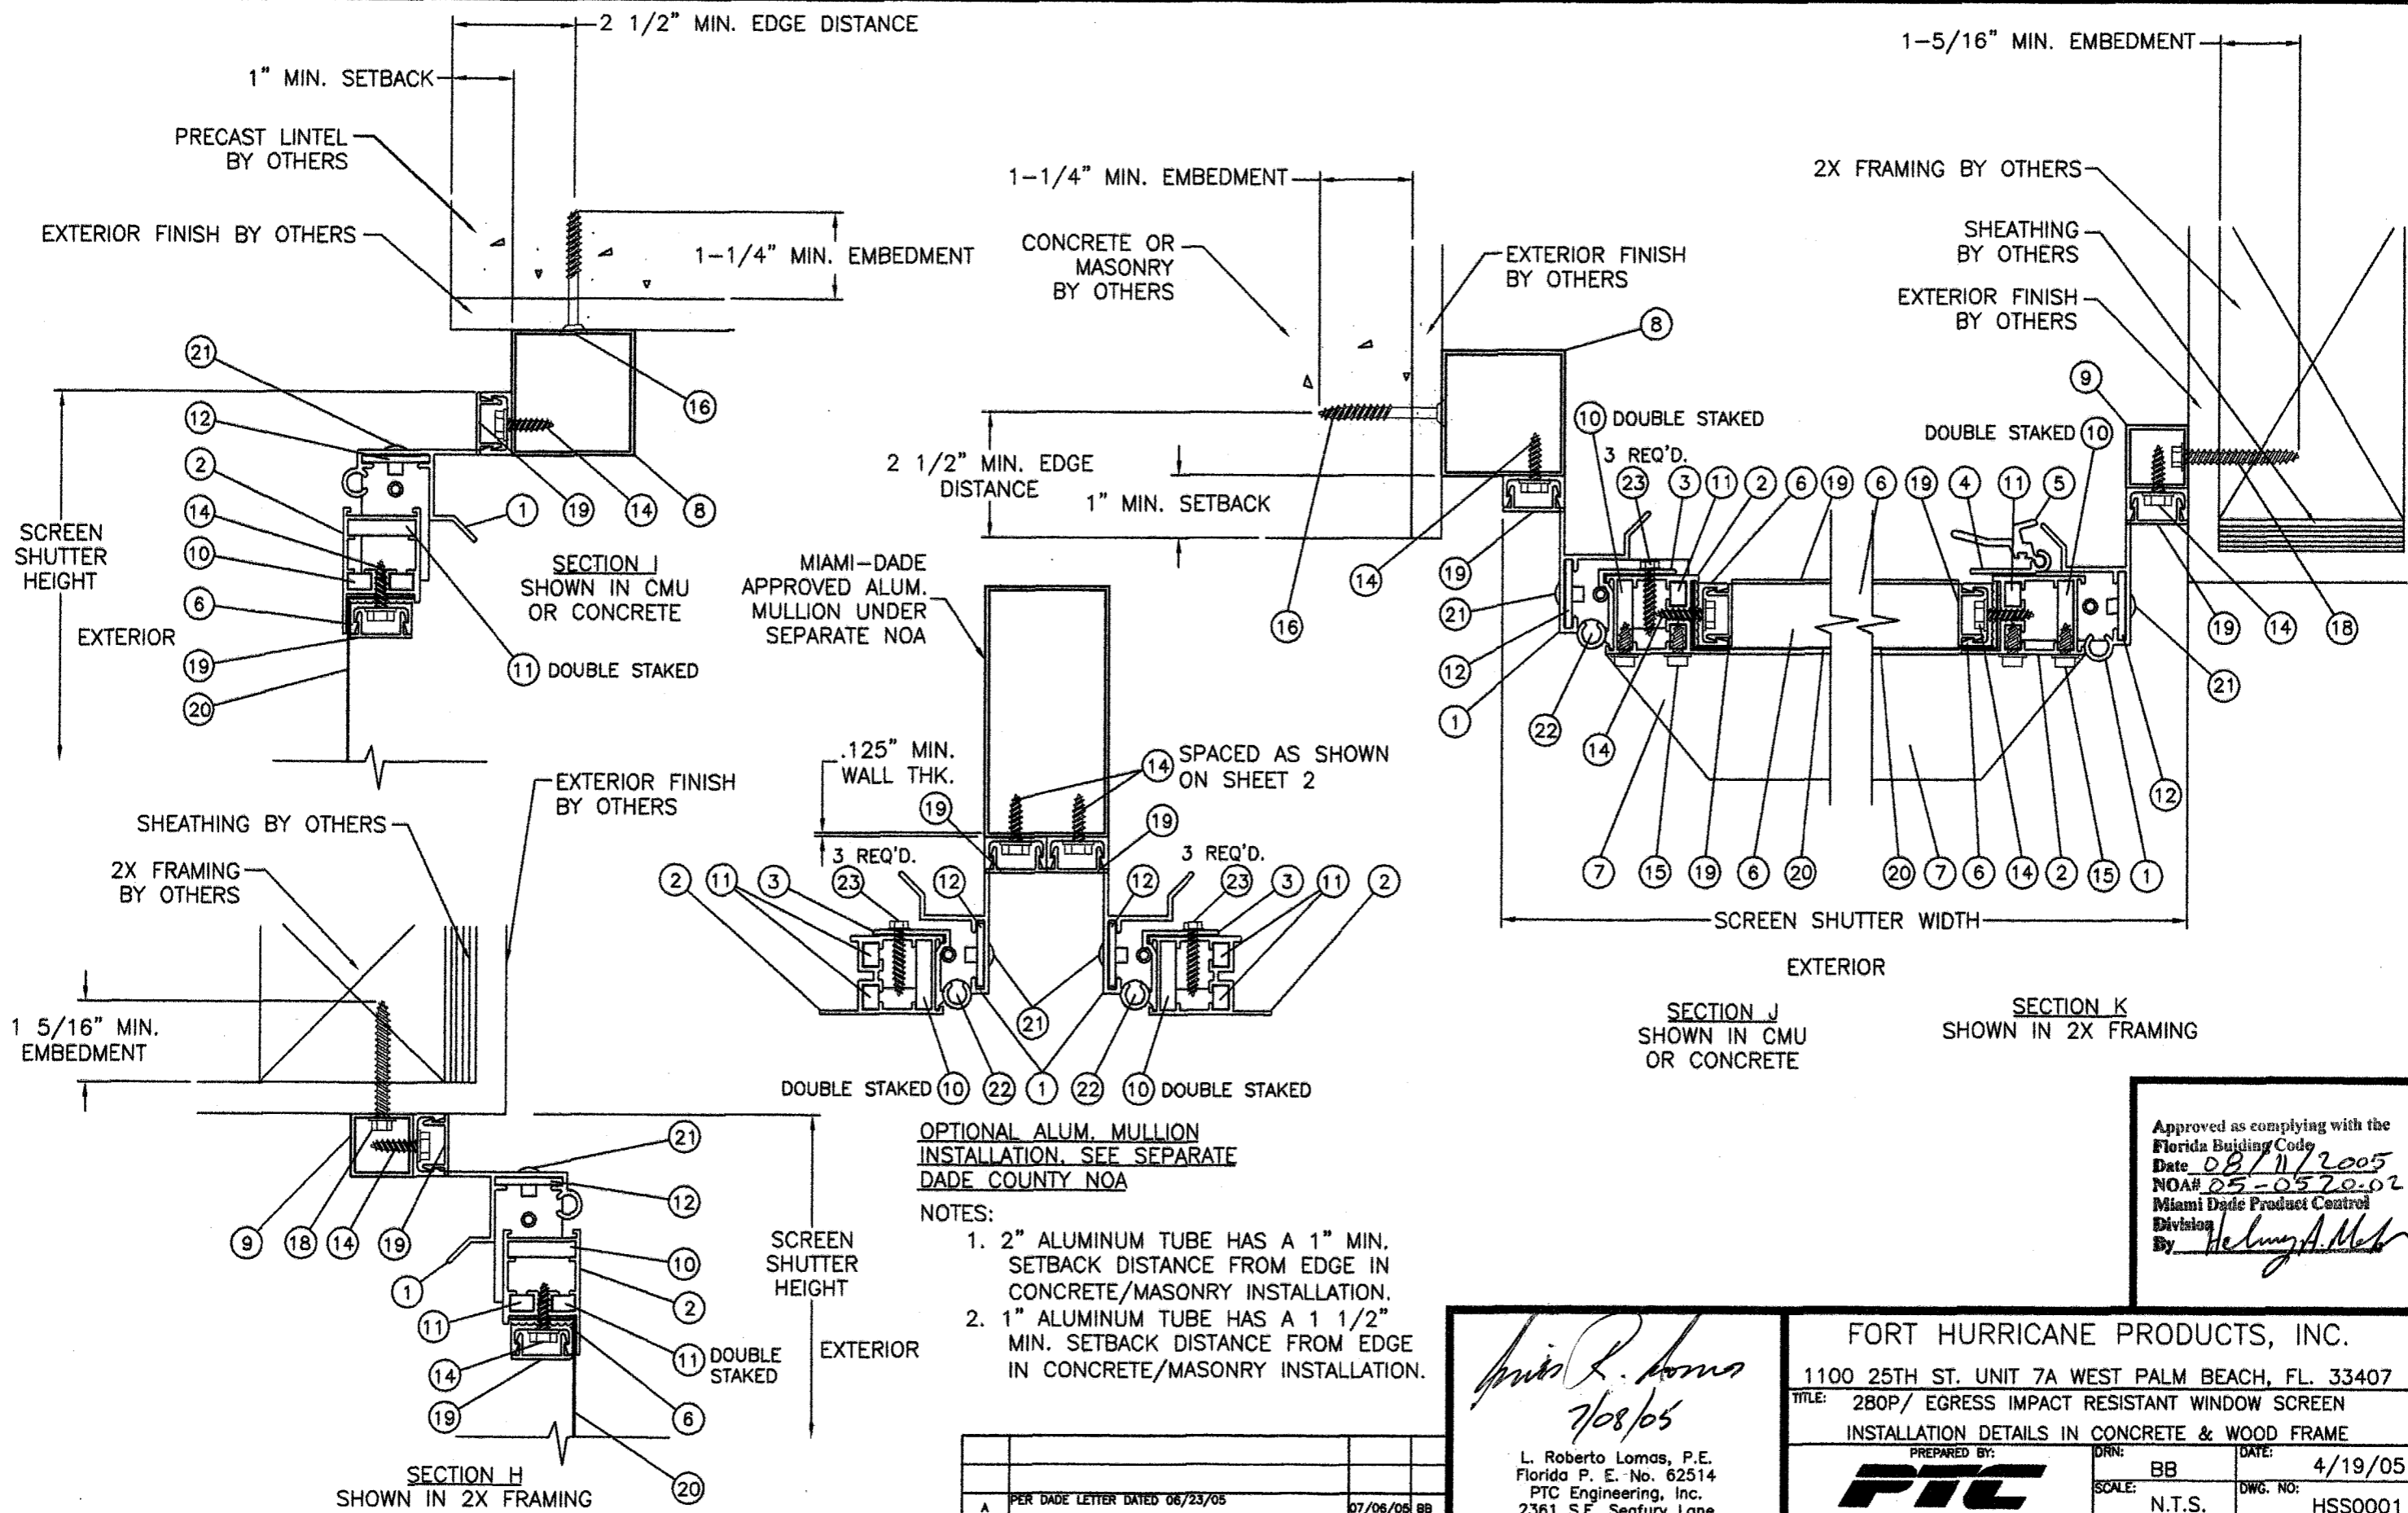

OPTIONAL ALUM. MULLION
INSTALLATION. SEE SEPARATE
DADE COUNTY NOA

NOTES:
1. 2" ALUMINUM TUBE HAS A 1" MIN.
SETBACK DISTANCE FROM EDGE IN
CONCRETE/MASONRY INSTALLATION.
2. 1" ALUMINUM TUBE HAS A 1 1/2"
MIN. SETBACK DISTANCE FROM EDGE
IN CONCRETE/MASONRY INSTALLATION.

Approved as complying with the
Florida Building Code
Date 08/11/2005
NOA# 05-0570-02
Miami Dade Product Control
Division
By Helmy A. Mab

L. Roberto Lomas
7/08/05

L. Roberto Lomas, P.E.
Florida P. E. No. 62514
PTC Engineering, Inc.
2361 S.E. Seafury Lane
Port St. Lucie, Florida 34952
FBPE Certificate of Authorization NO. 25935


FORT HURRICANE PRODUCTS, INC.
1100 25TH ST. UNIT 7A WEST PALM BEACH, FL. 33407
TITLE: 280P/ EGRESS IMPACT RESISTANT WINDOW SCREEN
INSTALLATION DETAILS IN CONCRETE & WOOD FRAME

PREPARED BY: **PTC** PTC ENGINEERING, INC.
Phone 772.398.4639 Fax 772.398.4654


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SCALE: N.T.S. DWG. NO: HSS0001
REV: A SHEET: 4 OF 5

A	PER DADE LETTER DATED 06/23/05	07/06/05	BB
SYM	REVISION	DATE	BY


① FRAME HEAD, SILL & JAMB
TYP. WALL THICKNESS 0.075

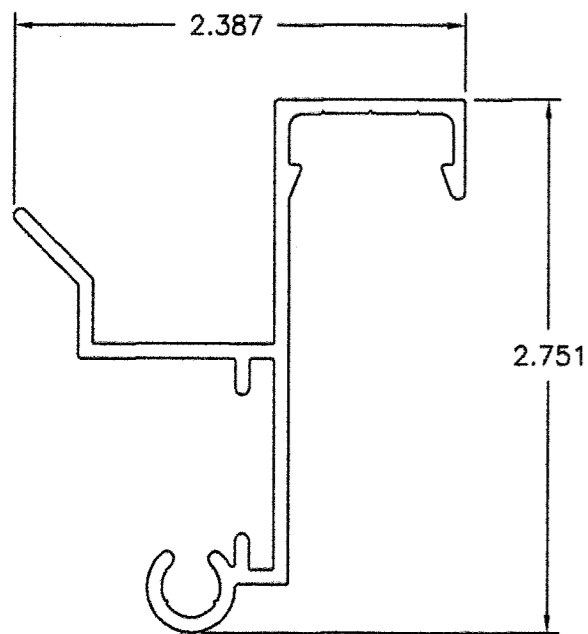


② VENT HEAD, SILL & JAMB
TYP. WALL THICKNESS 6005-T6

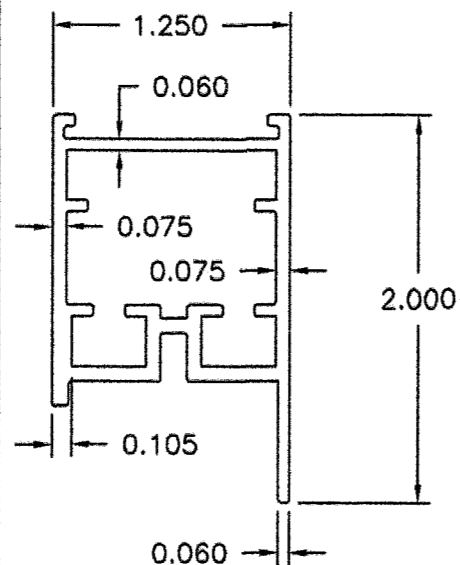


③ SCREEN HINGE
TYP. WALL THICKNESS 0.078
6005-T6

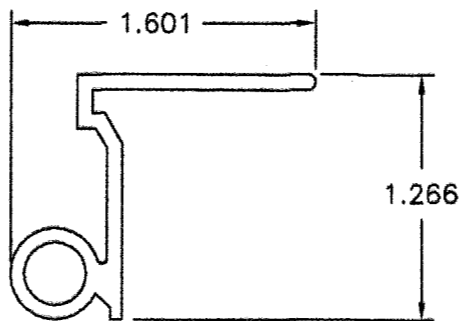


④ SCREEN LOCK PART A
TYP. WALL THICKNESS 0.078

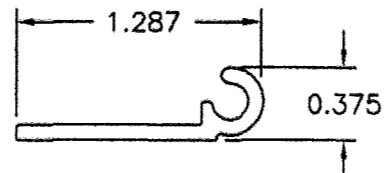


⑤ SCREEN LOCK PART B
TYP. WALL THICKNESS 0.094

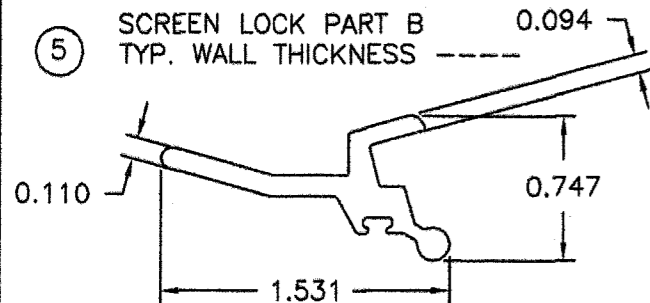


⑧ 2" X 2" ALUMINUM TUBE
TYP. WALL THICKNESS 0.062

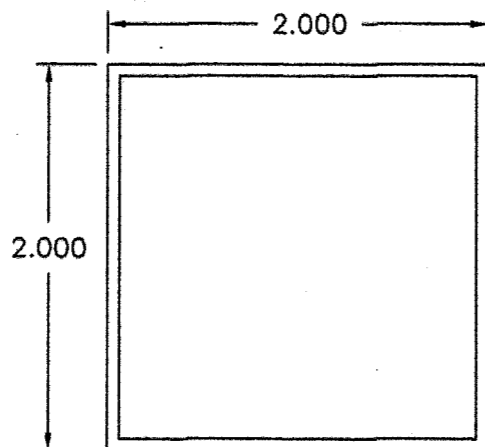


⑱ SCREEN COVER
TYP. WALL THICKNESS 0.050

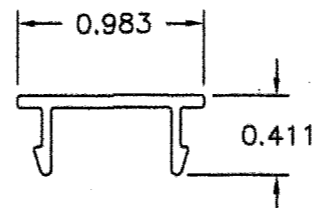


⑥ WIRE RETAINER
TYP. WALL THICKNESS 0.075

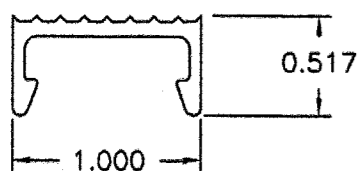

⑦ 1" X 2" ALUMINUM TUBE
TYP. WALL THICKNESS 0.125

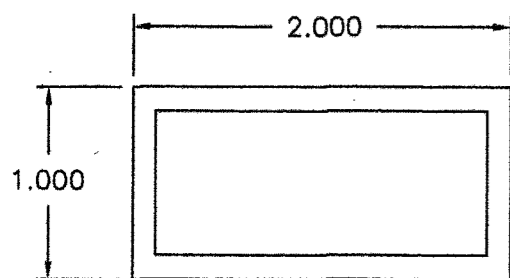

⑨ 1" X 1" ALUMINUM TUBE
TYP. WALL THICKNESS 0.062

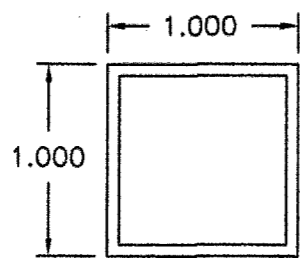

BILL OF MATERIALS

ITEM #	PART #	DESCRIPTION
1	2726	FRAME HEAD, SILL & JAMB 6005-T6 ALUMINUM
2	2711	VENT HEAD, SILL & STILE 6005-T6 ALUMINUM
3	2733	SCREEN HINGE 6005-T6 ALUMINUM
4	2724	SNAP LOCK PART A 6005-T6 ALUMINUM
5	2725	SNAP LOCK PART B 6005-T6 ALUMINUM
6	2721	WIRE RETAINER 6005-T6 ALUMINUM
7		1" X 2" X 1/8" ALUMINUM TUBE 6063-T5 ALUMINUM
8		2" X 2" X 1/16" ALUMINUM TUBE 6063-T5 ALUMINUM
9		1" X 1" & 1" X 2" X 1/16" ALUMINUM TUBE 6063-T5 ALUMINUM
10		OUTER VENT CORNER KEY 2" X 2" X 1.1 X 1/4" 6061-T6
11		INNER VENT CORNER KEY 2" X 2" X .400 X 1/8" 6061-T6
12		SUB FRAME ANGLE CORNER KEY 2" X 2" X 1/8" 6061-T6
13		#10 X 5/8" TEK SCREW
14		#12 -14 X 3/4" HEX HEAD SMS
15		#14 X 1/2" HEX HEAD SELF TAPPING FASTENER
16		1/4" X 2-1/4" TAPCON
17		NOT USED
18		1/4" LAG SCREW
19	2730	SCREW COVER
20		MESH 12 X 12 SCREEN SS 304 THREAD 0.028" OR 0.032" THICK
21		1/8" POP RIVET
22		SPRING LOADED HINGE PIN ASSEMBLY
23		#12 X 1" HEX HEAD SELF TAPPING SMS

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By Helmut A. M...

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TITLE: 280P/ EGRESS IMPACT RESISTANT WINDOW SCREEN
BILL OF MATERIALS & COMPONENTS

PREPARED BY:	DRN:	DATE:
PTC PTC ENGINEERING, INC.	BB	4/19/05
SCALE:	DWG. NO.:	
N.T.S.	HSS0001	
REV:	SHEET:	
A	5 OF 5	

Phone 772.398.4639 Fax 772.398.4654

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A	PER DADE LETTER DATED 06/23/05	07/06/05	BB